

Important No

- Prior to the commencement of work, the contractor and client a check on-site all exterior dimensions, boundary positions and de to verify and agree upon. Any errors, omissions or design change should be reported immediately to enable amended plans to be
- The contractor will be responsible for locating all hidden servic that may be affected by the proposal and stopping off or divert as necessary. Drainage runs shown are assumed and must be
- 3. The requirements of the "Party Wall Act 1995" will apply to certail schemes. The "Building Owner" will in writing inform and agree with the "Adjoining owner(s)" if the proposed work affects the Par Wall or is within 3 meters of the foundations of the nearby buildin If an agreement cannot be made then professional advice should I sought prior to commencement of work on site, by a Party Wall

Revision | Date | Description

swish

回数数数回

architecture & planning

3 Hardwick Grove The Park Nottingham NG7 1LG

T +44 (3) 115 783 8571 M +44 (3) 782 432 5278

E design.me@swish-architecture.co.ul W swish-architecture.co.uk

Client

Status Building Regulations
Project

PROPOSED
GROUND & FIRST FLOOR PLANS

Scale 1:50

Sheet Size A1

Drawn By TL

Date

Oct 16

Project No.

Drawing No.

Revision

336

BR-02

This drawing must not be reproduced in whole or part without written consent. Do not scale this drawing. All dimensions in millimeters. Written dimensions to be checked on site. Electronic issue to be confirmed by paper copy only. ©2016 SWISH Architecture Ltd. All Rights Reserved.

Notes



Proposed Cheadle Close Street Scene




Proposed Marshall Hill Drive Street Scene





Proposed Front Elevation

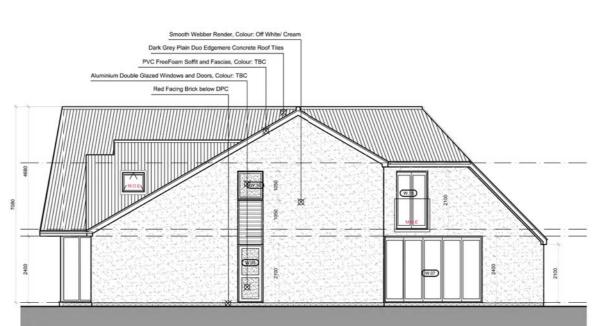


Proposed Side Elevation



Proposed Side Elevation



Proposed Rear Elevation

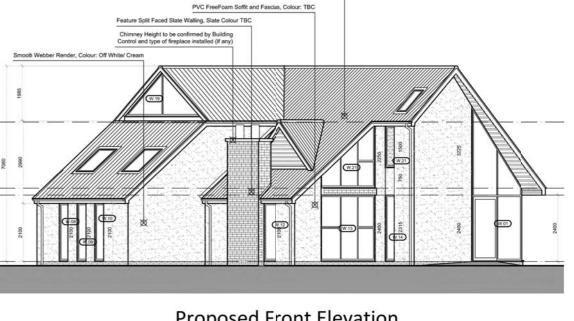

Proposed Front Elevation

architecture & planning 回数数数回

3 Hardwick Grove The Park Nottingham NG7 1LG


T +44 (3) 115 783 8571 M +44 (3) 782 432 5278


Status Building Regulations

PROPOSED ELEVATIONS

Sheet Size A1 Drawn By TL Date Oct 16 Scale 1:100. Project No. Drawing No. 336 BR-03 This drawing must not be reproduced in whole or part without written consent. Do not scale this drawing. All dimensions in millimeters. Written dimensions to be checked on site. Electronic issue to be confirmed by paper copy only. ©2016 SWISH Architecture Ltd. All Rights Reserved.

Notes

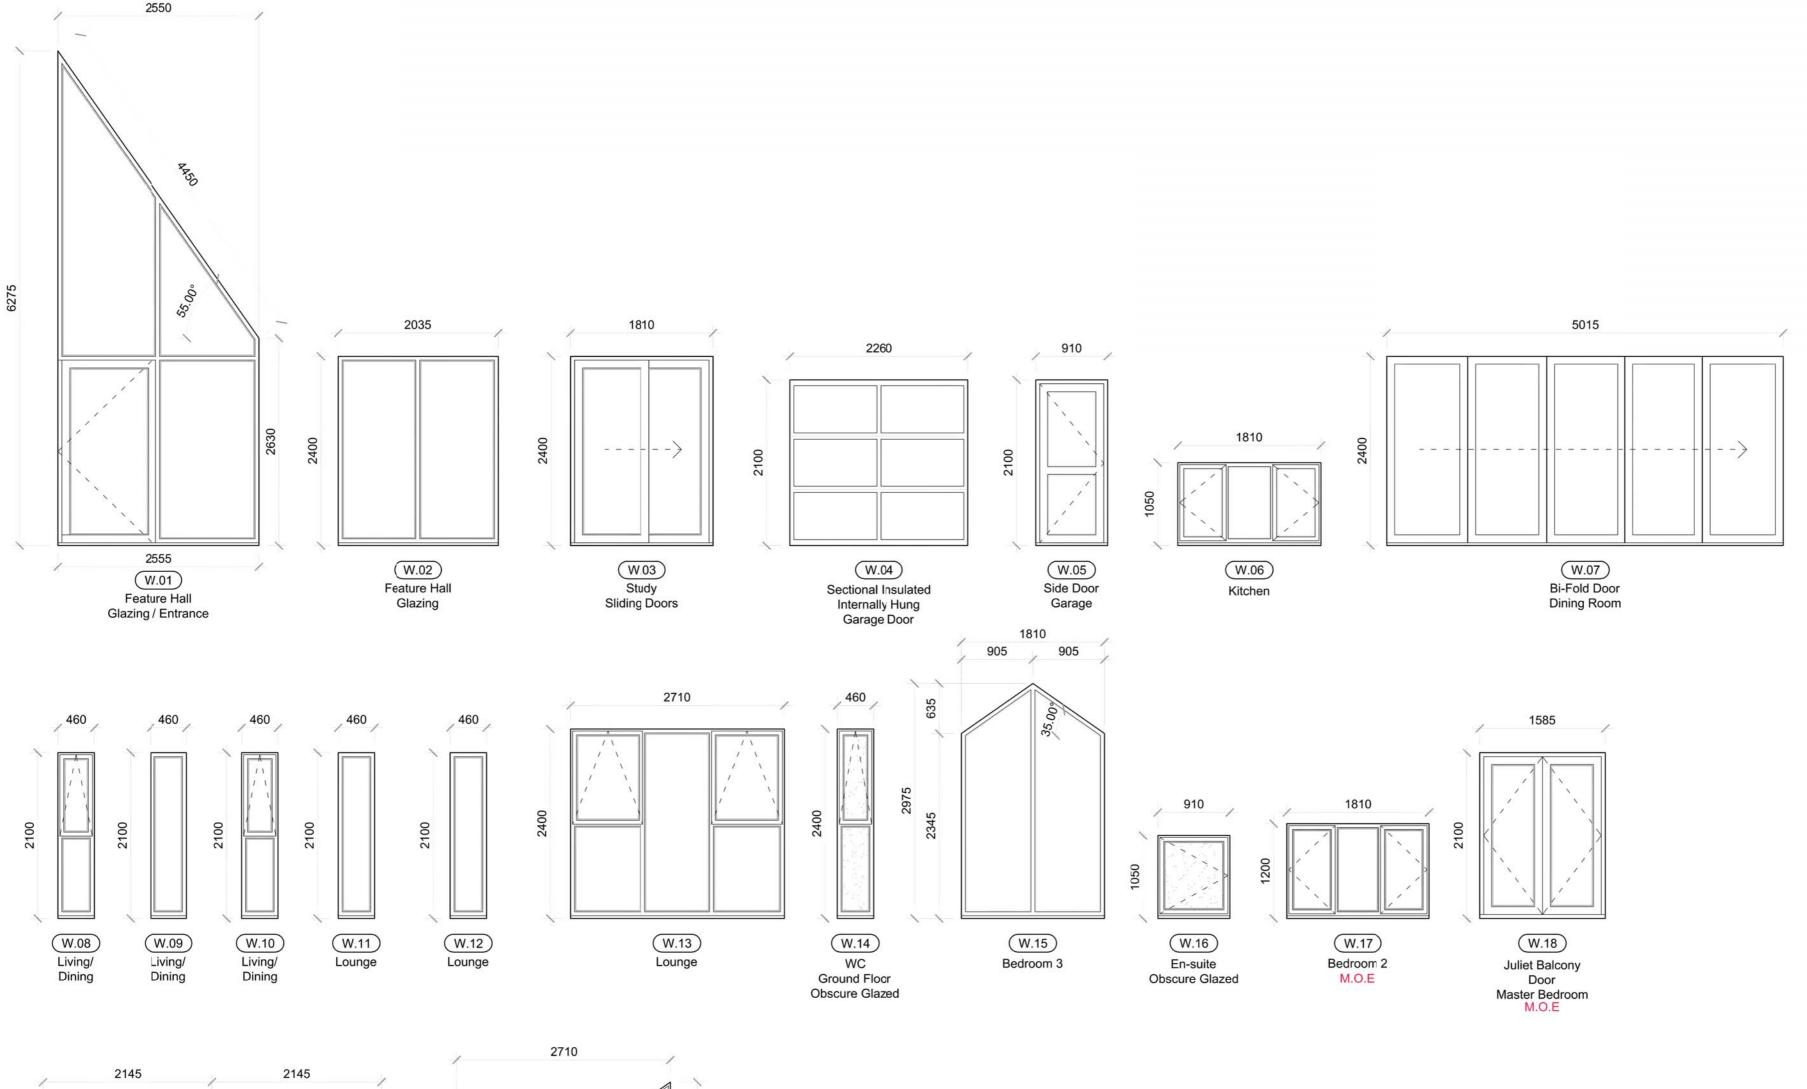

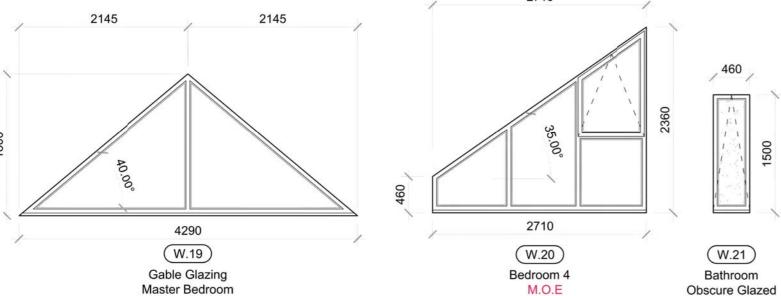

For quoting purposes only, all windows are to be checked on site before ordering and confirmed with client and contractor.

Notes

WINDOW SCHEDULE IS TO BE USED FOR QUOTING PURPOSED ONLY, ALL WINDOWS, DOORS AND MEANS OF ESCAPE ARE TO BE CHECKED ON SITE PRIOR TO

COMMENCEMENT OF ORDER.

WINDOWS, EXTERNAL DOORS

U-value: Area weighted average 0.18 W/m²k; Limiting Value 0.33 W/m²k.

New proprietary UPVC/Aluminium windows, styled as indicated on the drawings to be fixed strictly in accordance with the manufacturer's instructions. Open-able windows to be fitted with easy-clean hinges and brushed aluminium ironmongery to approved sample. All open able windows are to be fitted with clip release security restrictors. Ironmongery to Ground floor windows to be fitted with locks. (Note that no locks shall be fitted to windows noted M.O.E. - means of escape).

New proprietary PVC/ Aluminium doors,

style as indicated on the drawings to be

fixed strictly in accordance with the manufacturer's instructions. External doors to be hung in fully weather-stripped frame with proprietary threshold strips and anti-finger trap devices.

All external glazing to be low-e coated, double-glazed with 18mm air gap, in accordance with BS6206: 1981 (Safety Glazing). All units to be hermetically sealed. Toughened or laminated glass to BS 952-1:1995 shall be installed into all critical locations to resist breakage in accordance with BS 6206: 1981. This includes:

- · All internal and external glazed doors from ground level to a minimum height of 1500mm,
- Any glazed side panels within 300mm of the door from ground level to a minimum height of 1500mm,
- Any internal and external partitions from ground level to a minimum height of 800mm,
- Glazing sealants must be resistant to moisture and ultra-violet light.

Windows should provide 1/20th of floor area as rapid ventilation via opening windows, to all habitable rooms, with some part of the ventilation opening at high level

External windows and doors shall only be installed by a registered FENSA installer. A certificate shall be forwarded to building control within 30 days of completion of the installation work.

Proposed Window Schedule

Revision | Date | Description

architecture & planning

3 Hardwick Grove The Park Nottingham NG7 1LG


Status Building Regulations

Project No. Drawing No.

PROPOSED WINDOW SCHEDULE


Sheet Size A1 Drawn By TL Date Oct 16

336 BR-04

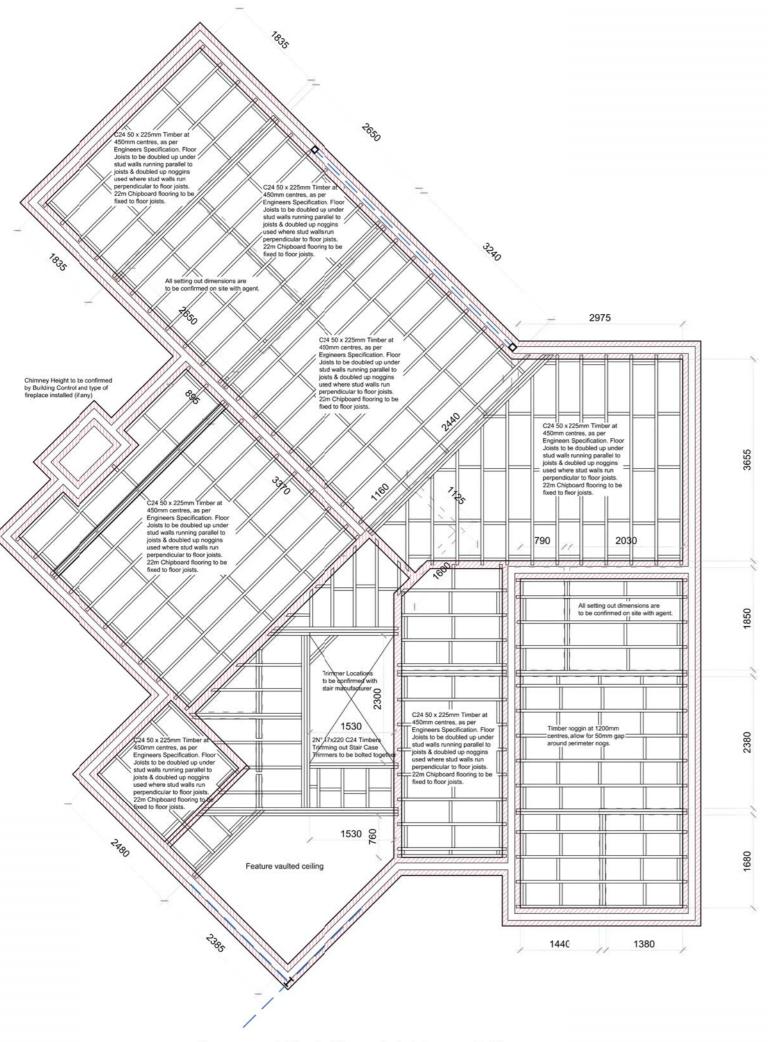

Proposed First Floor Joist Layout Plan

Notes

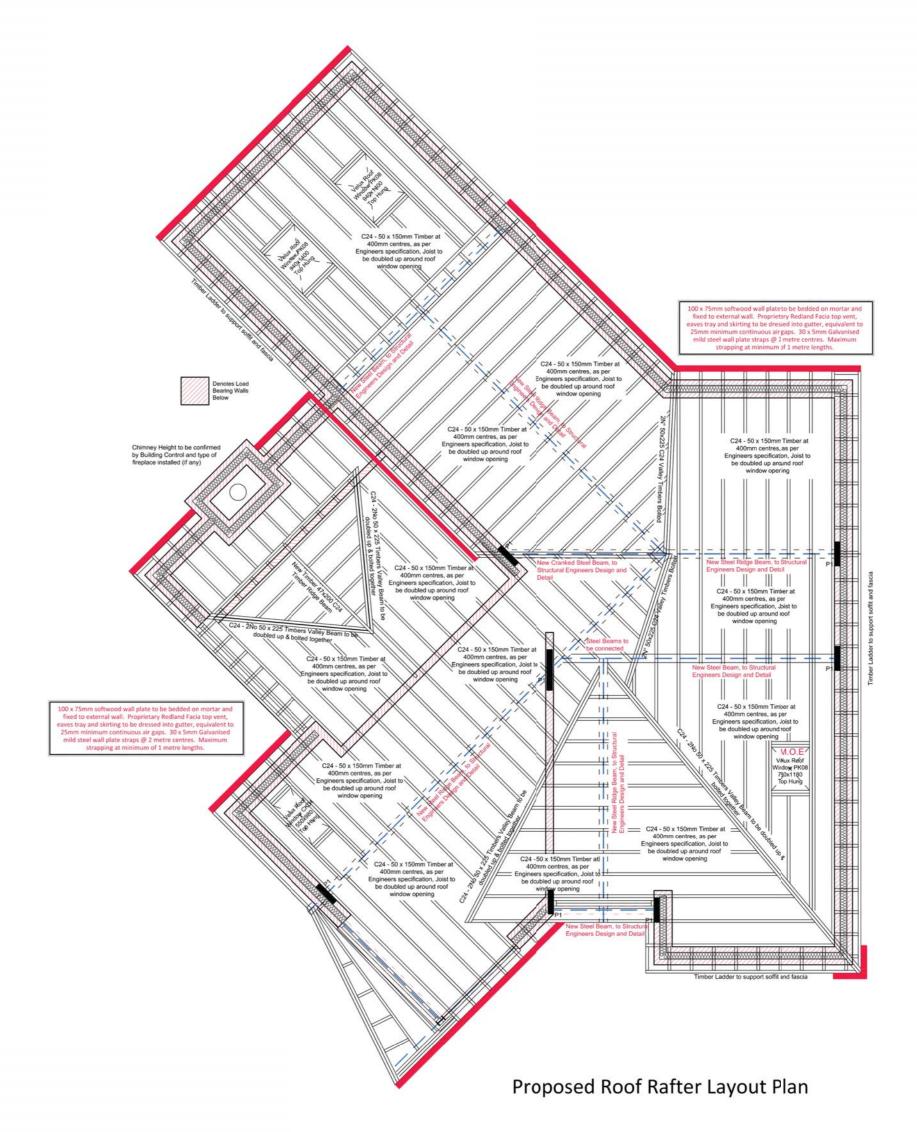

Important Note

- Prior to the commencement of work, the contractor and client are to check on-site all exterior dimensions, boundary positions and details to verify and agree upon. Any errors, omissions or design changes should be reported immediately to enable amended plans to be prepared and submitted for approval.
- The contractor will be responsible for locating all hidden servithat may be affected by the proposal and stopping off or diver as necessary. Drainage runs shown are assumed and must be the charten and the proposal and stopping of the proposal and stopping and the proposal and stopping and the proposal and stopping and the proposal and t
- 3. The requirements of the "Party Wall Act 1996" will apply to certain schemes. The "Building Owner" will in writing inform and agree with the "Adjoining owner(s)" if the proposed work affects the Party Wall or is within 3 meters of the foundations of the nearby building. If an agreement cannot be made then professional advice should be sought prior to commencement of work on site, by a Party Wall Surveyor. SWISH Architecture Ltd take no responsibility for this.

Revision | Date | Description



architecture & planning

3 Hardwick Grove The Park Nottingham NG7 1LG

+44 (2) 115 783 857

M +44 (3) 782 432 5278

E design.me@swish-architecture.

32 5278 wish-architecture.co.uk cture.co.uk


Status Building Regulations
Project

-


PROPOSED FLOOR JOIST LAYOUT & ROOF RAFTER LAYOUT PLANS.


Scale 1:50 Sheet Size A1 Drawn By TL Date Oct 16
Project No. Drawing No. Revision


336 BR-05
This drawing must not be reproduced in whole or part without written consent. Do n

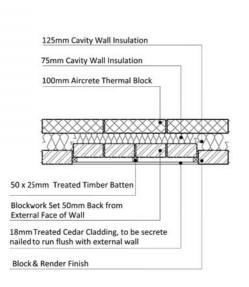


Flush Timber Cladding Detail

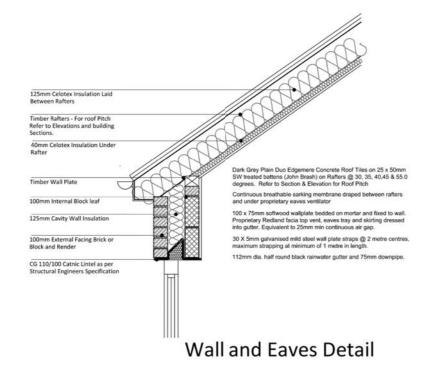

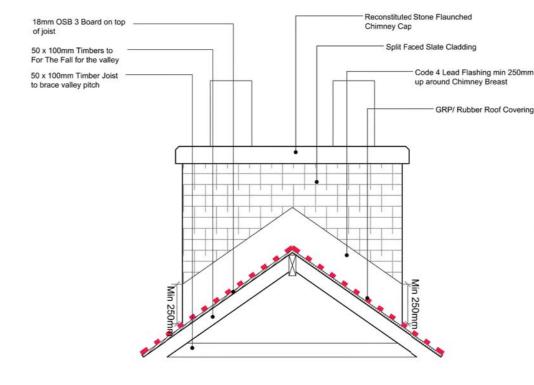


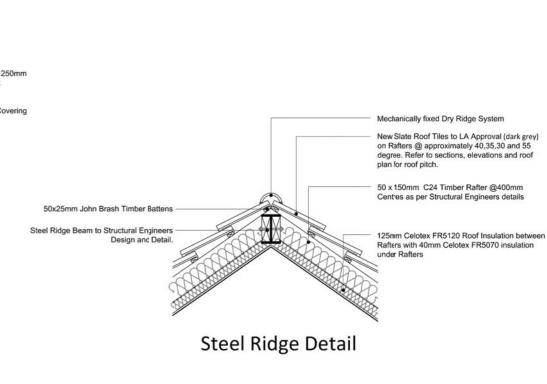


Chimney Flashing Detail

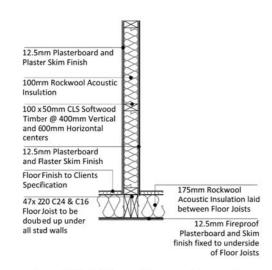


Stud Wall to Floor Detail

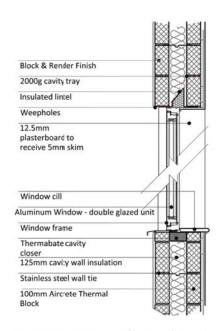

Masonry Wall and Window Detail

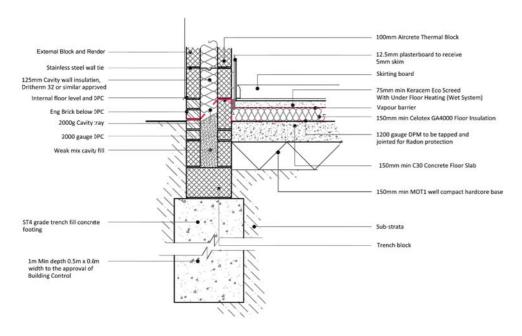



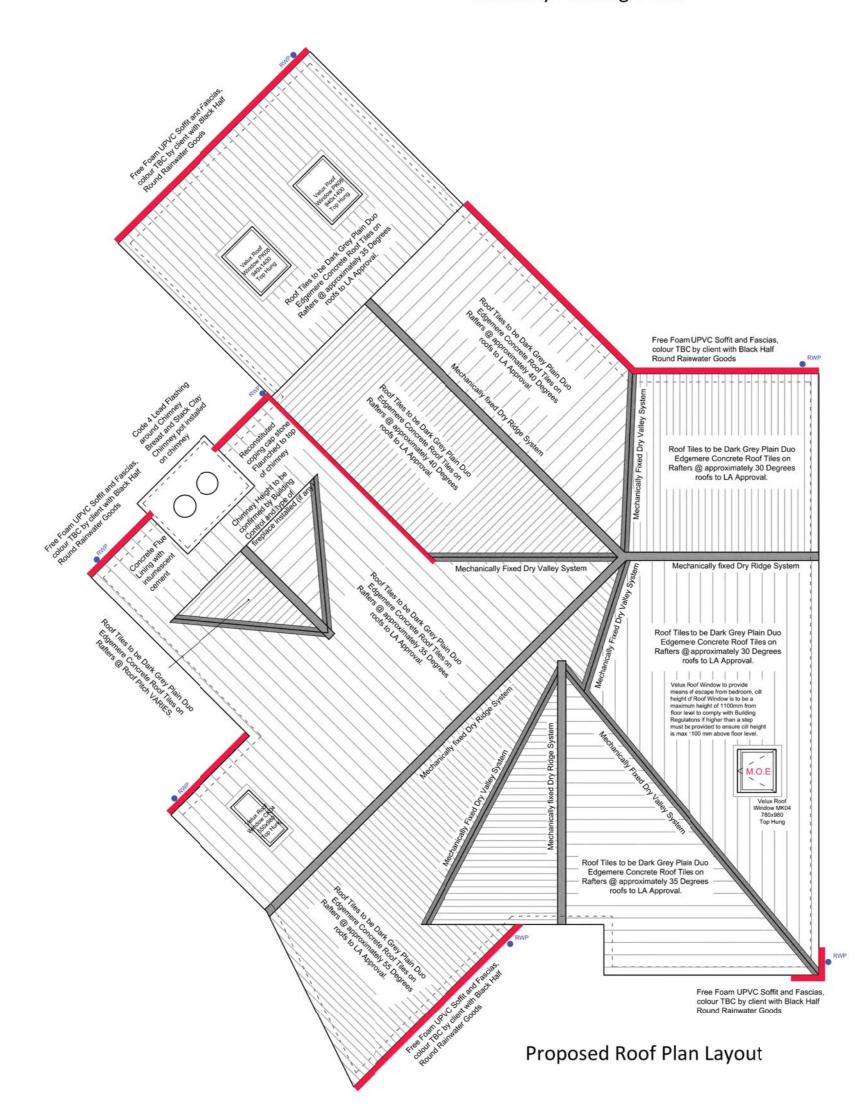

Revision | Date | Description

回数数数回

architecture & planning


3 Hardwick Grove The Park Nottingham NG7 1LG


Status Building Regulations

PROPOSED ROOF PLAN & CONSTRUCTION DETAILS.

Scale Varies. Sheet Size A1 Drawn By TL Date Oct 16 Project No. Drawing No. 336 BR-06

Notes

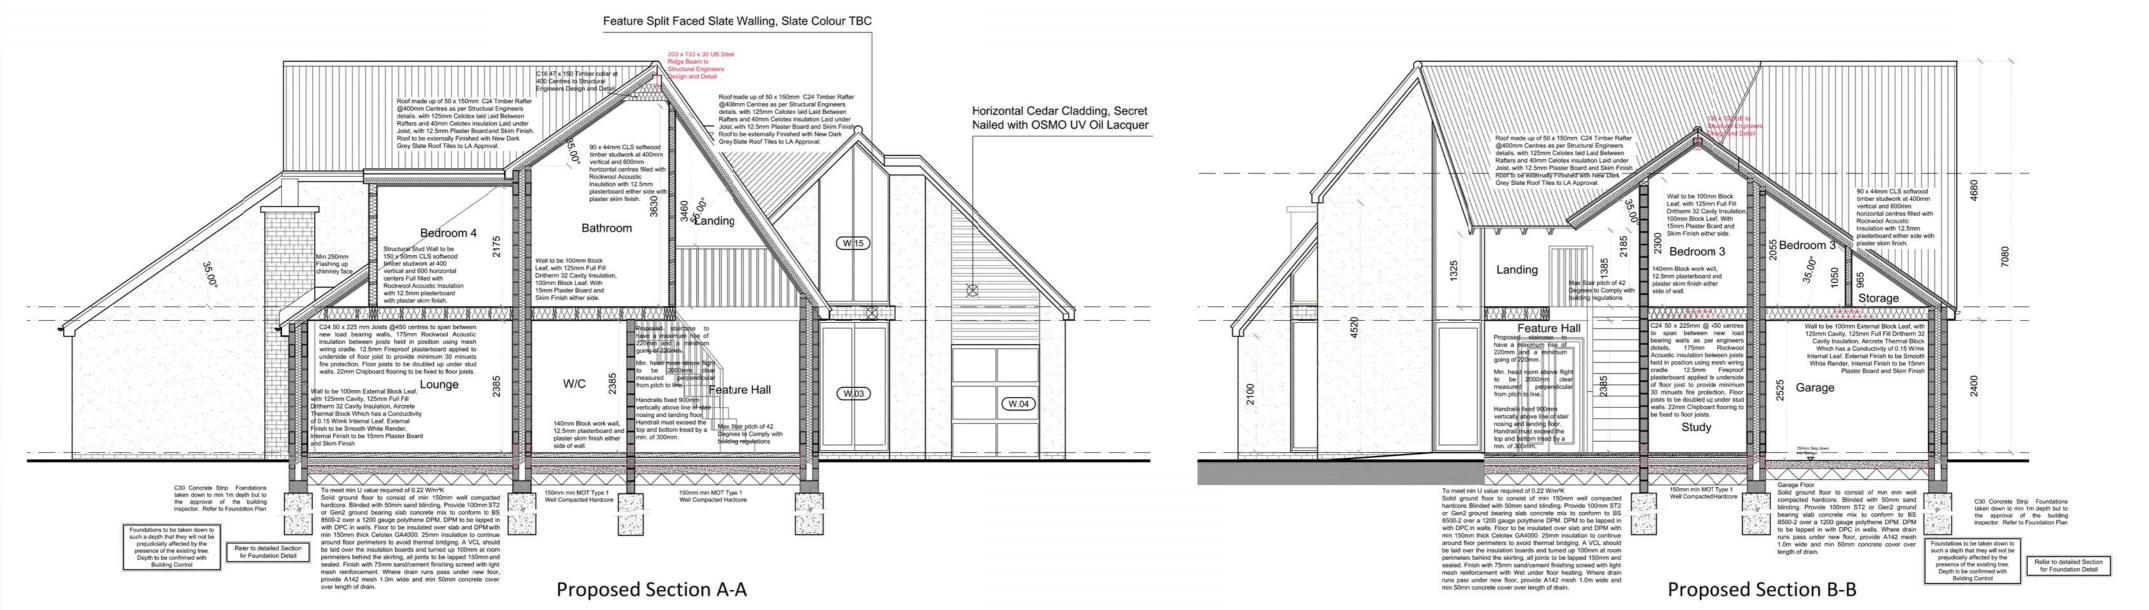

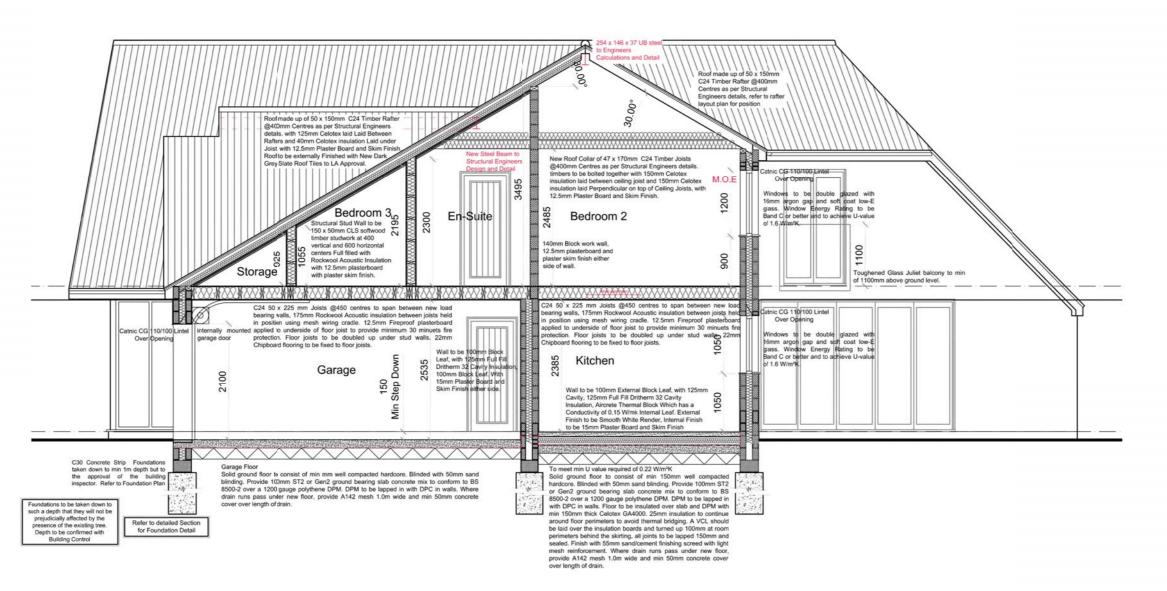

Proposed Section C-C

Notes

- to verify and agree upon. Any errors, omissions or design changes

Revision | Date | Description

architecture & planning

3 Hardwick Grove The Park Nottingham NG7 1LG

Status Building Regulations

PROPOSED BUILDING SECTIONS

Sheet Size A1 Drawn By TL Date Oct 16

Project No. Drawing No. 336 BR-07



Notes

- Prior to the commencement of work, the contractor and client are to check on-site all exterior dimensions, boundary positions and details to verify and agree upon. Any errors, omissions or design changes should be reported immediately to enable amended plans to be prepared and submitted for approval.

Revision | Date | Description



architecture & planning

3 Hardwick Grove The Park Nottingham NG7 1LG

M +44 (3) 782 432 5278

E design.me@swish-archite w swish-architecture.co.uk

Client

Status Building Regulations

PROPOSED SITE LAYOUT PLAN

Project No. Drawing No. 336 BR-08